Bushfire Attack Level (BAL) Certificate



In accordance with the provisions of clause 3.4 of the State Environmental Planning Policy (Exempt and Complying Development Codes) 2008 or, in accordance with Section 4.14(1)(b) of the Environmental Planning and Assessment Act 1979. This Certificate is to serve as notification that the part of the land on which the subject development is to be carried out and any associated access way is not in bush fire attack level – 40 (BAL-40) or the flame zone (BAL-FZ)

	Hotondo Homes		
CLIENT DETAILS:	sales@hotondomnc.com.au		
	79 Hastings River Drive, Port Macquarie NSW 2444		
SITE ADDRESS:	22 Driftwood Boulevard, Old Bar NSW 2430		
DESCRIPTION OF PROPOSAL:	Proposed attached units. Refer to Attachment 1 for proposed site plans.		
PLAN REFERENCES AND REPORTS: (Relied upon in report preparation)	Site plans supplied by client (Attachment 1).		
VEGETATION AND SLOPE ASSESSMENT	Grassland vegetation occurs to the West over cross-slope ground and at a distance of 20m from the proposed attached units. Forest vegetation occurs to the North over downslope (0-5°) ground and at a distance of >80m from the proposed attached units. No other vegetation considered to be a bushfire threat occurs within 100m of the Eastern and Southern elevations. Refer to Figure 2-1 for site location.		
BAL RATING:	The proposed attached units has been assessed as BAL-12.5 in accordance with Table A1.12.6 of PBP 2019. To Note: The construction requirements for the next lower BAL than that determined for the site may be applied to an elevation of the building where the elevation is not exposed to the source of the bushfire attack. An elevation is deemed to be not exposed to the source of bushfire attack if all the straight lines between that elevation and the source of bushfire attack are obstructed by another part of the building. However, this does not apply to BAL-12.5		
COMPLYING DEVELOPMENT CHECKLIST	Refer to Attachment 2 for compliance with development standards.		
DOES THE PROPOSAL RELY ON ALTERNATE SOLUTIONS?	YES NO (Circle the relevant response) (If YES, the application is to be referred to NSW RFS for assessment.)		

Firebird ecoSultants Pty Ltd

Level 3/6 Bolton Street, Newcastle NSW 2300 PO Box 354, Newcastle NSW 2300 P: 02 4910 3939 M: 0414 465 990 E: s

E: sarah@firebirdeco.com.au



General Recommendations:

- The areas of the site not built on should be managed as an Inner Protection Area (IPA) in accordance with the NSW RFS document 'Standards for Asset Protection Zones' and Appendix 4 of PBP.
- ➢ Home owners should prepare a Bush Fire Survival Plan refer to the RFS Website http://www.rfs.nsw.gov.au/file system/attachments/Attachment BushFireSurvivalPlan.pdf.

Ι	Sarah Jones	of	Firebird ecoSultants Pty Ltd
	(Print Name)		(Trading or Company Name)

have carried out a bushfire risk assessment on the above-mentioned proposal and property.

REPORT REFERENCE:	Old Bar – Hotondo Homes	
REPORT DATE:	27 th June 2024	
REPORT EXPIRY DATE:	27 th June 2025	
CERTIFICATE NO / ACCREDITED SCHEME:	FPA - BPAD – A – Certified Practitioner (BPD-26512)	

I hereby certify, in accordance with Section 4.14 of the *Environmental Planning and Assessment Act* 1979:

- 1. That I am a person recognised by the *NSW Rural Fire Service* as a qualified consultant in bushfire risk assessment.
- 2. The development conforms to the relevant specifications and requirements, that being; Planning for Bushfire Protection 2019 and AS3959 2018 NSW Variation

* In accordance with the provisions of Clause 3.4 of the State Environmental Planning Policy (Exempt and Complying Development Codes) 2008 this Certificate is to serve as notification that the part of the land on which the subject development is to be carried out and any associated access way is not in bush fire attack level – 40 (BAL-40) or the flame zone (BAL-FZ) or I certify the development conforms to the relevant specifications and requirements of Planning for Bushfire Protection 2019"





DATE: 27th June 2024

Firebird ecoSultants Pty LtdLevel 3/6 Bolton Street, Newcastle NSW 2300PO Box 354, Newcastle NSW 2300P: 02 4910 3939M: 0414 465 990E: sarah(0)

E: <u>sarah@firebirdeco.com.au</u>



ABN-16 105 985 993

Figure 1-1: Bushfire Prone Land Map



 Firebird ecoSultants Pty Ltd

 Level 3/6 Bolton Street, Newcastle NSW 2300

 PO Box 354, Newcastle NSW 2300


 P: 02 4910 3939
 M: 0414 465 990

 E: sarah@firebirdeco.com.au

Note: this certificate must be completed and signed by a person recognized by the NSW Rural Fire Service as a qualified consultant in bush fire risk assessment



Figure 2-1: Vegetation Map

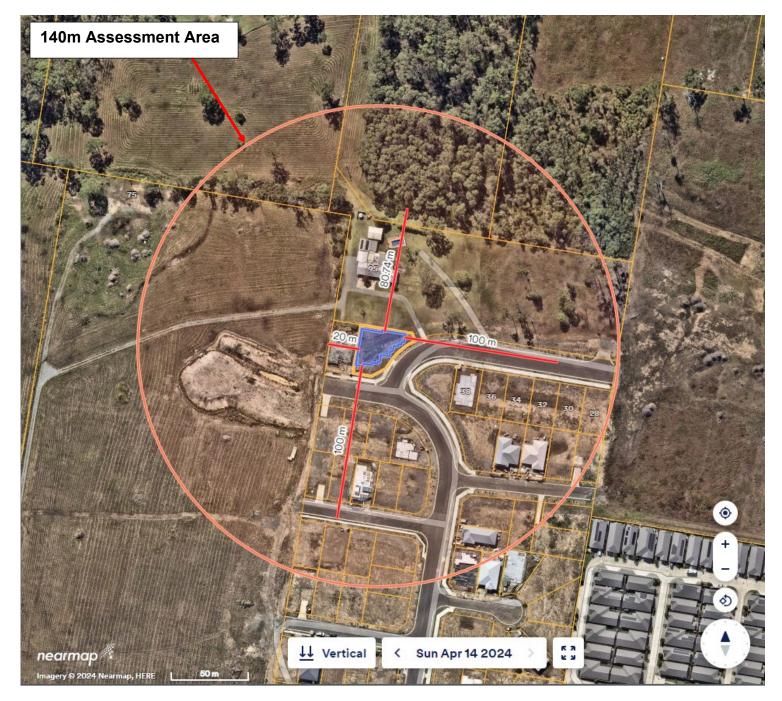

Firebird ecoSultants Pty Ltd Level 3/6 Bolton Street, Newcastle NSW 2300

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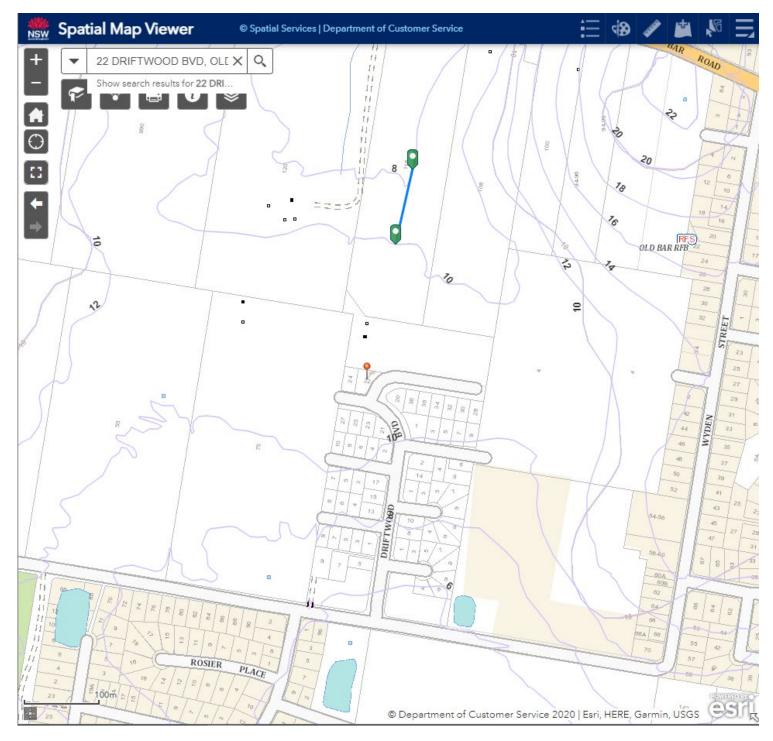
E: sarah@firebirdeco.com.au

Note: this certificate must be completed and signed by a person recognized by the NSW Rural Fire Service as a qualified consultant in bush fire risk assessment



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Figure 3-1: Slope



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E: sarah@firebirdeco.com.au



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Attachment 1 – Site Plans

 Firebird ecoSultants Pty Ltd


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 PO Box 354, Newcastle NSW 2300

 P: 02 4910 3939
 M: 0414 465 990

 E: sarah@firebirdeco.com.au


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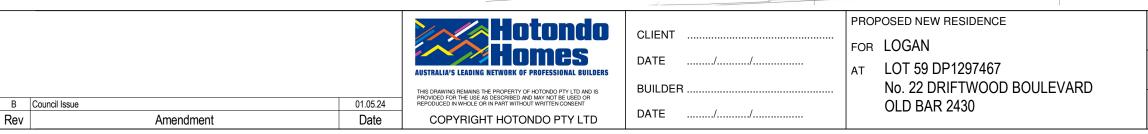




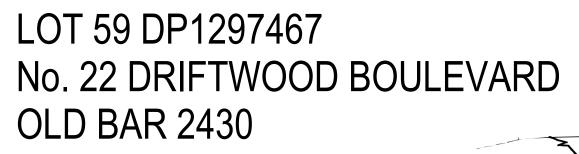


Sheet List			
Sheet Number Sheet Name			
00	COVER SHEET		
01-1	SITE PLAN		
02-1	FLOOR PLAN 1.125		
02-2	FLOOR PLAN 1.100		
03-1	ELEVATIONS		
03-2	ELEVATIONS		
04-1	SECTION		
05-1	SLAB LAYOUT		
05-2	BRICKWORK SETOUT		
06	ELECTRICAL		
07-1	KITCHEN DETAILS		
08-1	WET AREA DETAILS		
08-2	WET AREA DETAILS		




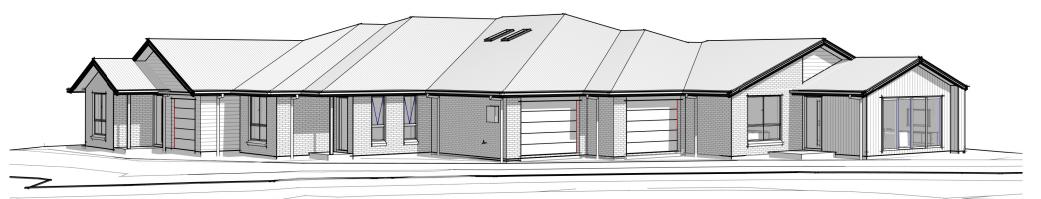



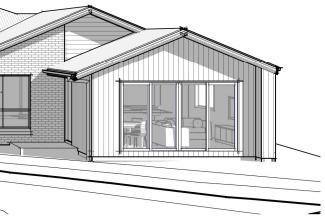

BASIX CERT. No.	SCALE	
	DATE	01.05.2024
PLAN	DRAWN	T.J.W
CUSTOM GABLES	DRAFT REF. No.	141-24
TITLE COVER SHEET	JOB No.	dwg No. 00

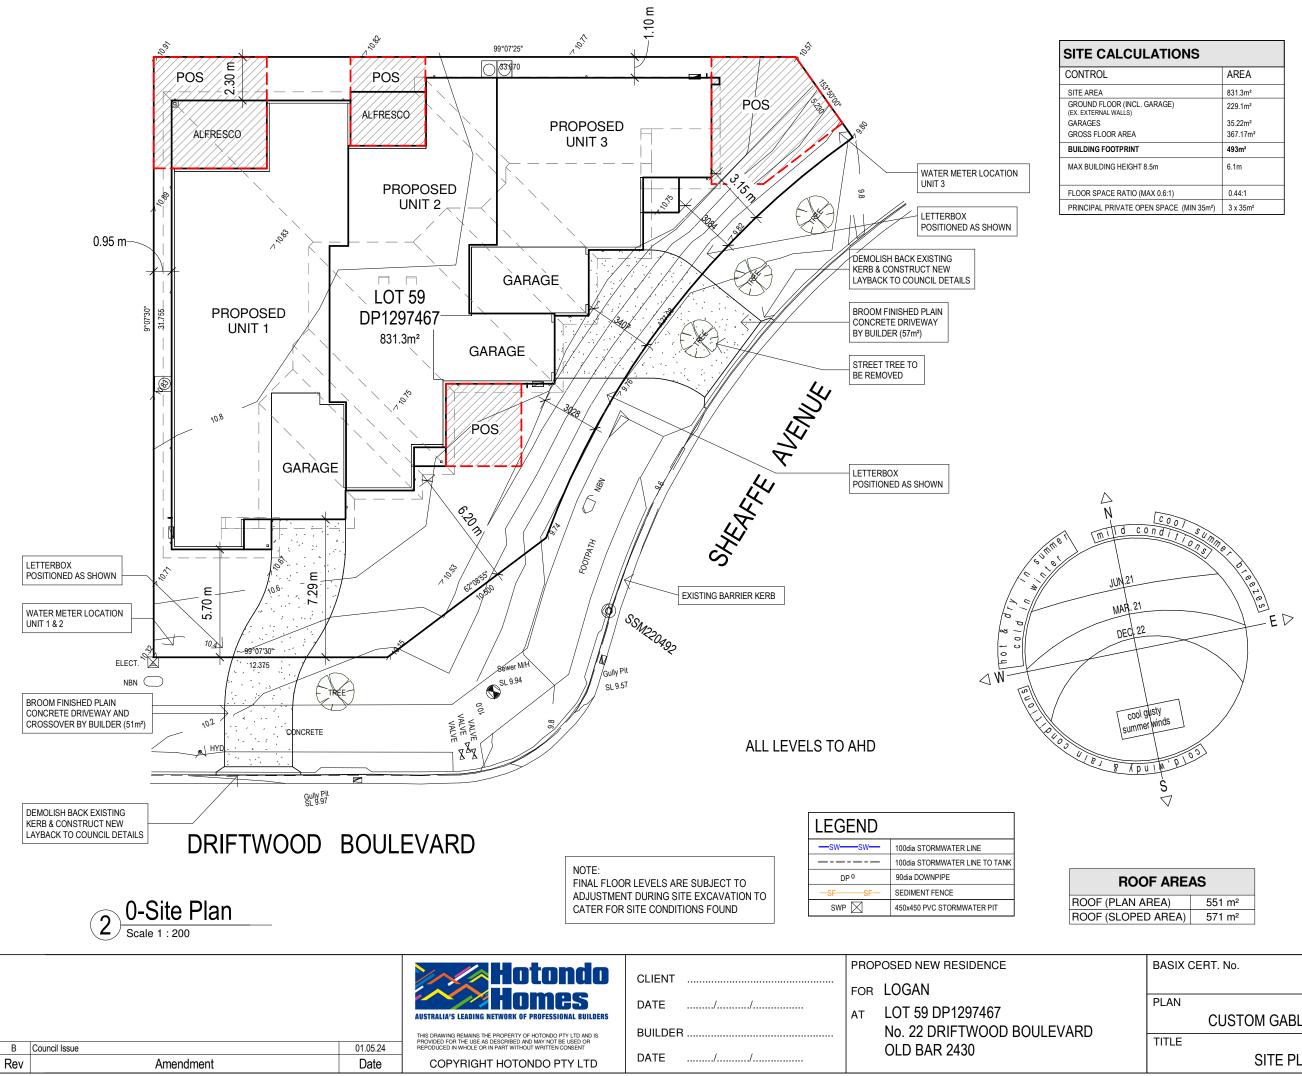


ATIONS			
	AREA		
	831.3m²		
GARAGE)	229.1m²		
	35.22m² 367.17m²		
	493m ²		
3.5m	6.1m		
AX 0.6:1)	0.44:1		
EN SPACE (MIN 35m ²)	3 x 35m²		

STANDARD NOTES 1. ALL WRITTEN DIMENSION TAKE PRECEDENCE OVER SCALE. 2. ALL ROOF BEAMS. LINTELS AND BRICKWORK ANGLES TO TRUSS/WALL FRAME MANUFACTURER'S SPECIFICATIONS AND ENGINEERS VERIFICATION. 3. WC DOORS TO COMPLY WITH BCA VOL 2 PART 10.4.2. 4. ALL WET AREAS TO BE COMPLETED IN ACCORDANCE WITH BCA VOL 2 PT 10.2. 5. ENGINEER DESIGNED - PREFABRICATED TIMBER ROOF TRUSSES AS PER MANUFACTURER'S SPECIFICATIONS. (600 CTS UNLESS NOTED OTHERWISE). 6. 90mm PREFABRICATED TIMBER WALL FRAMES AS PER MANUFACTURER'S SPECIFICATIONS, U.N.O. 7. BUILDER & TRADES ARE TO CONFIRM ALL MEASUREMENTS, DETAILS & SPECIFICATIONS PRIOR TO SET-OUT BE ORDERING OF MATERIALS. 8. REPORT ANY ERRORS FOR CLARIFICATION/CORRECTION AS NO RESPONSIBILITY WILL BE TAKEN AFTER CONSTRUCTION HAS COMMENCED. 9. ALL ELECTRICAL APPLIANCE & PLUMBING SYMBOLS ARE DIAGRAMMATIC ONLY. REFER TO BUILDERS SPECIFICATION FOR DETAILS OF ALL FIXTURES. 10. SIZE AND LOCATION OF DOWNPIPES TO BE CONFIRMED ON SITE BY BUILDER. 11. ALL WORK TO BE CONSTRUCTED IN ACCORDANCE WITH THE BUILDING CODE OF AUSTRALIA AND RELEVANT TRADE AND TECHNICAL MANUALS.	
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ACCORDANCE WITH THE BUILDING CODE OF AUSTRALIA AND RELEVANT TRADE AND	
OF AUSTRALIA AND RELEVANT TRADE AND	
TECHNICAL MANUALS.	

F AREAS			
REA)	551 m²		
D AREA)	571 m ²		

AREAS			
UNIT '	1		
A	Living	162.13 m ²	
В	Garage	25.33 m ²	
С	Alfresco	18.75 m ²	
D	Porch	2.63 m ²	
UNIT [·]	1:4	208.85 m ²	
UNIT 2	2		
E	Living	130.75 m ²	
F	Garage	22.65 m ²	
G	Alfresco	14.88 m ²	
Н	Porch	1.68 m ²	
UNIT 2:4		169.96 m ²	
UNIT 3	3		
1	Living	88.91 m ²	
J	Garage	22.17 m ²	
K	Porch	3.51 m ²	
UNIT 3:3		114.60 m ²	
Grand total: 11		493.41 m ²	

BASIX CERT. No.		SCALE	As indicated
		DATE	01.05.2024
PLAN		DRAWN	T.J.W
	CUSTOM GABLES	DRAFT REF. No.	141-24
TITLE	SITE PLAN	JOB No.	DWG No. 01-1
	011212011		•••

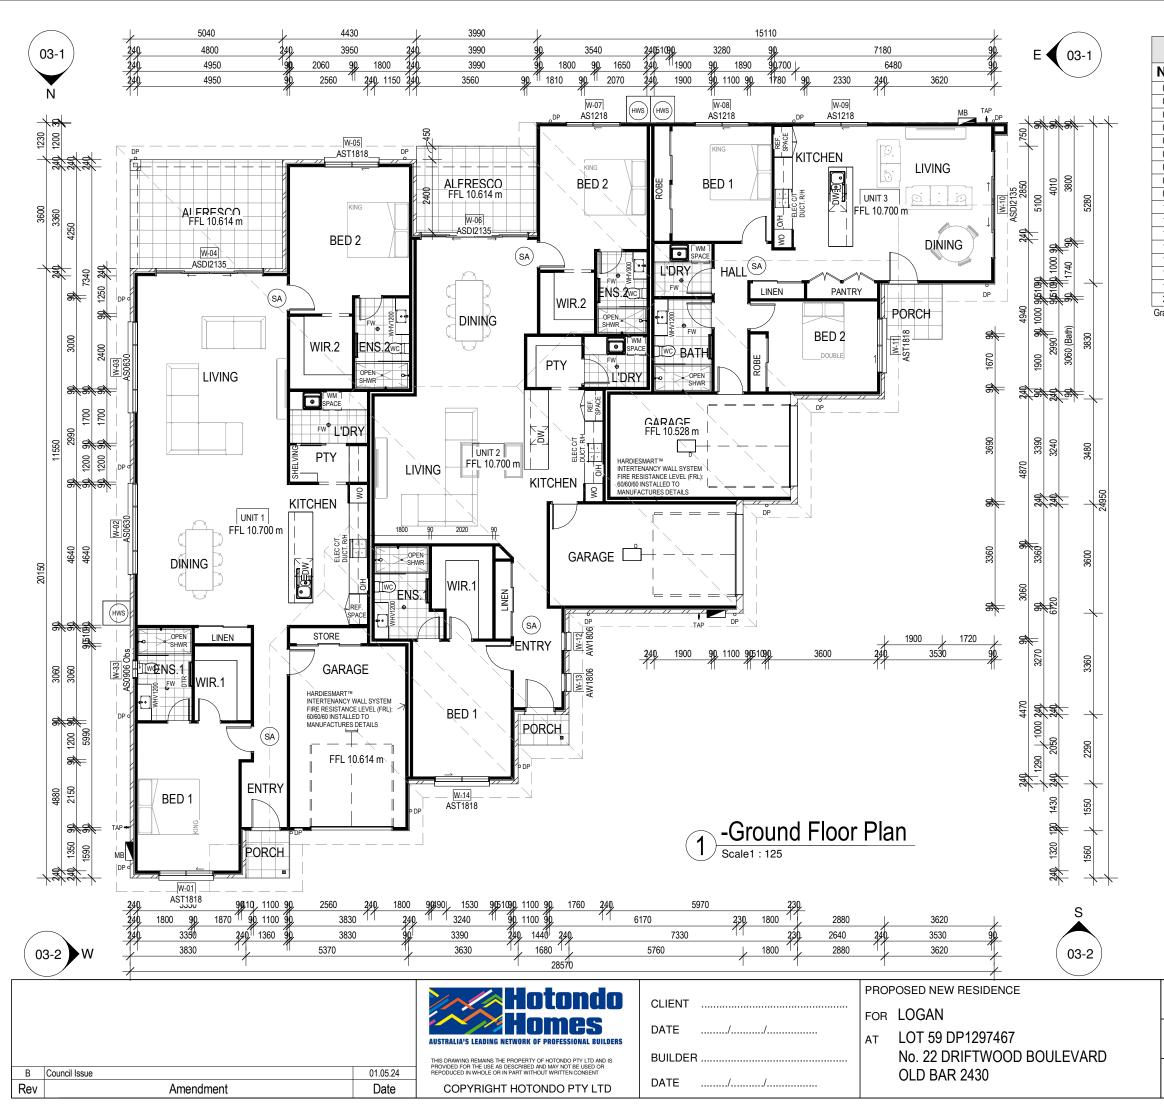

No.	Height	Width	Area	
01	1800	1810	3.26 m ²	
02	600	3010	1.81 m²	
03	600	3010	1.81 m ²	
04	2100	3580	7.52 m ²	
05	1800	1810	3.26 m ²	
06	2100	3580	7.52 m ²	
07	1200	1810	2.17 m ²	
08	1200	1810	2.17 m ²	
09	1200	1810	2.17 m ²	
10	2100	3580	7.52 m ²	
11	1800	1810	3.26 m ²	
12	1800	600	1.08 m ²	
13	1800	600	1.08 m ²	
14	1800	1810	3.26 m ²	
15	1200	568	0.68 m ²	
16	1200	568	0.68 m ²	
33	860	610	0.52 m²	
rand to	otal: 17		49.76 m ²	

LEGEND					
CPT	CARPET				
CT	CERAMIC TILES				
C/T	COOK TOP				
DP	DOWNPIPE				
DPS	DOWNPIPE & SPREADER				
DTR/TR	TOWEL RAIL (DOUBLE) / (SINGLE)				
HK	ROBE HOOK @ 1750				
FT	TIMBER LAMINATE FLOORING				
FFL	FINISHED FLOOR LEVEL				
GFL	GARAGE FLOOR LEVEL				
FW	FLOOR WASTE				
HWS	HEATPUMP HOT WATER SYSTEM				
MB	RECESSED ELECTRICAL METER BOX				
M/H	CEILING MANHOLE				
MX	MIXER				
O/H	OVERHEAD CUPBOARDS				
POL	POLISHED CONCRETE FLOOR				
RAIL	700mm SHOWER RAIL				
R/H	RANGEHOOD (DUCTED)				
S/D	SETDOWN				
ST	SERVICES STACK				
S	SPOUT				
Т	TAP				
RT	TOWEL RING @ 1100				
Trns	TRANSLUCENT GLASS				
TRH	TOILET ROLL HOLDER				
WM	WASHING MACHINE				
WC	TOILET				
VP	VINYL PLANK FLOORING				
V1200	VANITY & LENGTH				
WHV1200	WALL HUNG VANITY & LENGTH				
720 LOH	DOOR WITH LIFT OF HINGES				
720 P	DOOR WITH PRIVACY LOCK				
SA	SMOKE ALARM				
CEILING FAN LIGHT COMBO					

ROOF AREAS					
ROOF (PLAN AREA) 551 m ²					
ROOF (SLOPED AREA) 571 m ²					

AREAS							
UNIT 1							
A	Living	162.13 m ²					
В	Garage	25.33 m ²					
С	Alfresco	18.75 m ²					
D	Porch	2.63 m ²					
UNIT 1	: 4	208.85 m ²					
UNIT 2							
E Living		130.75 m ²					
F	Garage	22.65 m ²					
G	Alfresco	14.88 m ²					
H Porch		1.68 m ²					
UNIT 2	: 4	169.96 m ²					
UNIT 3							
I Living		88.91 m ²					
J	Garage	22.17 m ²					
K	Porch	3.51 m ²					
UNIT 3	: 3	114.60 m ²					
Grand	total: 11	493.41 m ²					

SCALE	As indicated
DATE	01.05.2024
DRAWN	T.J.W
DRAFT REF. No.	141-24
JOB No.	DWG No. 02-1
	DATE DRAWN DRAFT REF. No.



1 Ground Floor Plan Scale 1 : 100


 B
 Council Issue
 01.05.24

 Rev
 Amendment
 Date

Window Schedule					
No.	Height	Width	Description	Area	
01	1800	1810	Sliding Window	3.26 m ²	
02	600	3010	Sliding Window	1.81 m ²	
03	600	3010	Sliding Window	1.81 m ²	
04	2100	3580	Sliding Door	7.52 m ²	
05	1800	1810	Sliding Window	3.26 m ²	
06	2100	3580	Sliding Door	7.52 m ²	
07	1200	1810	Sliding Window	2.17 m ²	
08	1200	1810	Sliding Window	2.17 m ²	
09	1200	1810	Sliding Window	2.17 m ²	
10	2100	3580	Sliding Door	7.52 m ²	
11	1800	1810	Sliding Window	3.26 m ²	
12	1800	600	Awning Window	1.08 m ²	
13	1800	600	Awning Window	1.08 m ²	
14	1800	1810	Sliding Window	3.26 m ²	
15	1200	568	Fixed (non-operating) skylight	0.68 m ²	
16	1200	568	Fixed (non-operating) skylight	0.68 m ²	
33	860	610	Sliding Window	0.52 m ²	
Grand to	otal: 17			49.76 m ²	

CT C/T DP DPS DTR / TR HK FT FFL GFL	CARPET CERAMIC TILES COOK TOP DOWNPIPE DOWNPIPE & SPREADER TOWEL RAIL (DOUBLE) / (SINGLE) ROBE HOOK @ 1750 TIMPED LANNATE EL CODINIC			
C/TDP DPS DTR / TR HK FT FFL GFL	COOK TOP DOWNPIPE DOWNPIPE & SPREADER TOWEL RAIL (DOUBLE) / (SINGLE) ROBE HOOK @ 1750			
DP DPS DTR/TR HK FT FFL GFL	DOWNPIPE DOWNPIPE & SPREADER TOWEL RAIL (DOUBLE) / (SINGLE) ROBE HOOK @ 1750			
DPS DTR / TR HK FT FFL GFL	DOWNPIPE & SPREADER TOWEL RAIL (DOUBLE) / (SINGLE) ROBE HOOK @ 1750			
DTR / TR HK FT FFL GFL	TOWEL RAIL (DOUBLE) / (SINGLE) ROBE HOOK @ 1750			
HK FT FFL GFL	ROBE HOOK @ 1750			
FT FFL GFL				
FFL GFL				
GFL	TIMBER LAMINATE FLOORING			
-	FINISHED FLOOR LEVEL			
	GARAGE FLOOR LEVEL			
FW	FLOOR WASTE			
HWS	HEATPUMP HOT WATER SYSTEM			
MB	RECESSED ELECTRICAL METER BOX			
M/H	CEILING MANHOLE			
MX	MIXER			
O/H	OVERHEAD CUPBOARDS			
POL	POLISHED CONCRETE FLOOR			
RAIL	700mm SHOWER RAIL			
R/H	RANGEHOOD (DUCTED)			
S/D	SETDOWN			
ST	SERVICES STACK			
S	SPOUT			
Т	TAP			
RT	TOWEL RING @ 1100			
Trns	TRANSLUCENT GLASS			
TRH	TOILET ROLL HOLDER			
WM	WASHING MACHINE			
WC	TOILET			
VP	VINYL PLANK FLOORING			
V1200	VANITY & LENGTH			
	WALL HUNG VANITY & LENGTH			
	DOOR WITH LIFT OF HINGES			
720 P	DOOR WITH PRIVACY LOCK			
SA	SMOKE ALARM			


Room Schedule			
UNIT 1			
ALFRESCO	18.02 m ²		
BED 1	16.84 m ²		
BED 2	18.02 m ²		
DINING	23.46 m ²		
ENS.1	5.51 m ²		
ENS.2	5.40 m ²		
ENTRY	8.18 m ²		
GARAGE	22.94 m ²		
KITCHEN	12.09 m ²		
L'DRY	4.35 m ²		
	33.98 m ²		
PORCH	2.25 m ²		
PTY	3.07 m ²		
WIR.1	4.60 m ²		
WIR.2	-		
UNIT 1: 15	4.94 m ²		
	183.66 m		
UNIT 2	44.00		
ALFRESCO	11.29 m ²		
BED 1	14.48 m ²		
BED 2	15.63 m ²		
DINING	16.85 m ²		
ENS.1	5.95 m ²		
ENS.2	4.47 m ²		
ENTRY	7.41 m ²		
GARAGE	20.73 m ²		
KITCHEN	11.43 m ²		
L'DRY	3.46 m ²		
LIVING	26.44 m ²		
PORCH	1.68 m ²		
PTY	3.02 m ²		
WIR.1	5.70 m ²		
WIR.2	3.65 m ²		
UNIT 2: 15	152.18 m		
UNIT 3			
BATH	5.81 m ²		
BED 1	12.46 m ²		
BED 2	12.56 m ²		
DINING	9.34 m ²		
GARAGE	20.24 m ²		
HALL	6.38 m ²		
KITCHEN	13.24 m ²		
L'DRY	3.31 m ²		
	-		
	14.01 m ²		
PORCH	3.46 m ²		
UNIT 3: 10	100.82 m		
Grand total: 40	436.66 m		

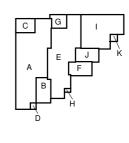

551 m²						

AREAS						
UNIT 1						
A	Living	162.13 m ²				
В	Garage	25.33 m ²				
С	Alfresco	18.75 m ²				
D	Porch	2.63 m ²				
UNIT 1	: 4	208.85 m ²				
UNIT 2	UNIT 2					
E Living		130.75 m ²				
F Garage		22.65 m ²				
G Alfresco		14.88 m ²				
H Porch		1.68 m ²				
UNIT 2	: 4	169.96 m ²				
UNIT 3	1					
I	Living	88.91 m ²				
J	Garage	22.17 m ²				
K	Porch	3.51 m ²				
UNIT 3	: 3	114.60 m ²				
Grand total: 11 493.41 m						
I J K UNIT 3	Living Garage Porch : 3	22.17 m ² 3.51 m ²				

	Hotondo	CLIENT	FOR LOGAN	BASIX CERT. No.	SCALE DATE DRAWN	As indicated 01.05.2024 T.J.W
	AUSTRALIA'S LEADING NETWORK OF PROFESSIONAL BUILDERS	BUILDER	AT LOT 59 DP1297467 No. 22 DRIFTWOOD BOULEVARD-	CUSTOM GABLES	DRAFT REF. No.	4537
24	THIS DRAWING REMANS THE PROPERTY OF HOTOMOD PTY LTD AND IS PROVIDED FOR THE USE AS DESCRIBED AND MAY NOT BE USED OR REPODUCED IN WHOLE OR IN PART WITHOUT WRITTEN CONSENT COPYRIGHT HOTONDO PTY LTD	DATE/	OLD BAR 2430	TITLE FLOOR PLAN 1.100	JOB No.	DWG No. 02-2

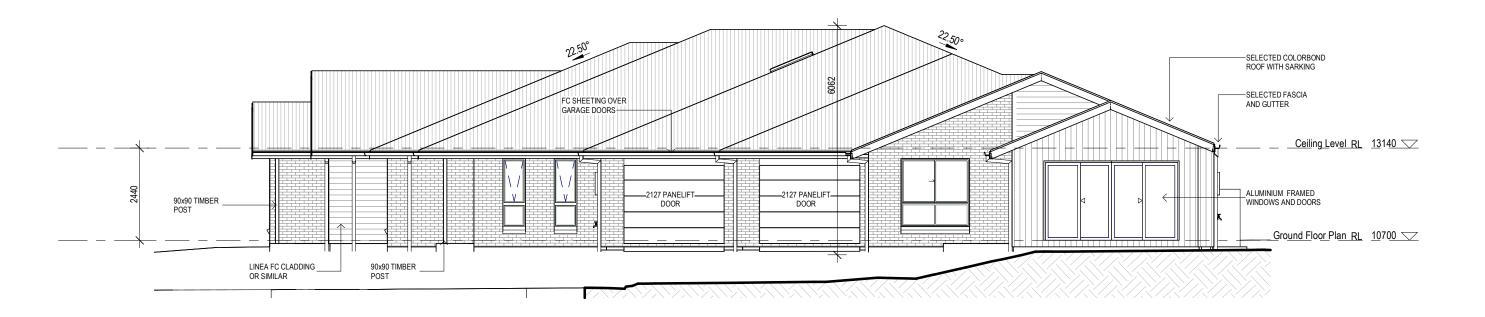









			AUSTRALIA'S LEADING NETWORK OF PROFESSIONAL BUILDERS		PROPOSED NEW RESIDENCE FOR LOGAN AT LOT 59 DP1297467
			THIS DRAWING REMAINS THE PROPERTY OF HOTONDO PTY LTD AND IS PROVIDED FOR THE USE AS DESCRIBED AND MAY NOT BE USED OR	BUILDER	No. 22 DRIFTWOOD BOULEVARD
В	Council Issue	01.05.24	REPODUCED IN WHOLE OR IN PART WITHOUT WRITTEN CONSENT		OLD BAR 2430
Rev	Amendment	Date	COPYRIGHT HOTONDO PTY LTD	DATE///	

BASIX CE	RT. No.	SCALE	1 : 100
		DATE	01.05.2024
PLAN		DRAWN	T.J.W
	CUSTOM GABLES	DRAFT REF. No.	141-24
TITLE		JOB No.	DWG No.
	ELEVATIONS		03-1

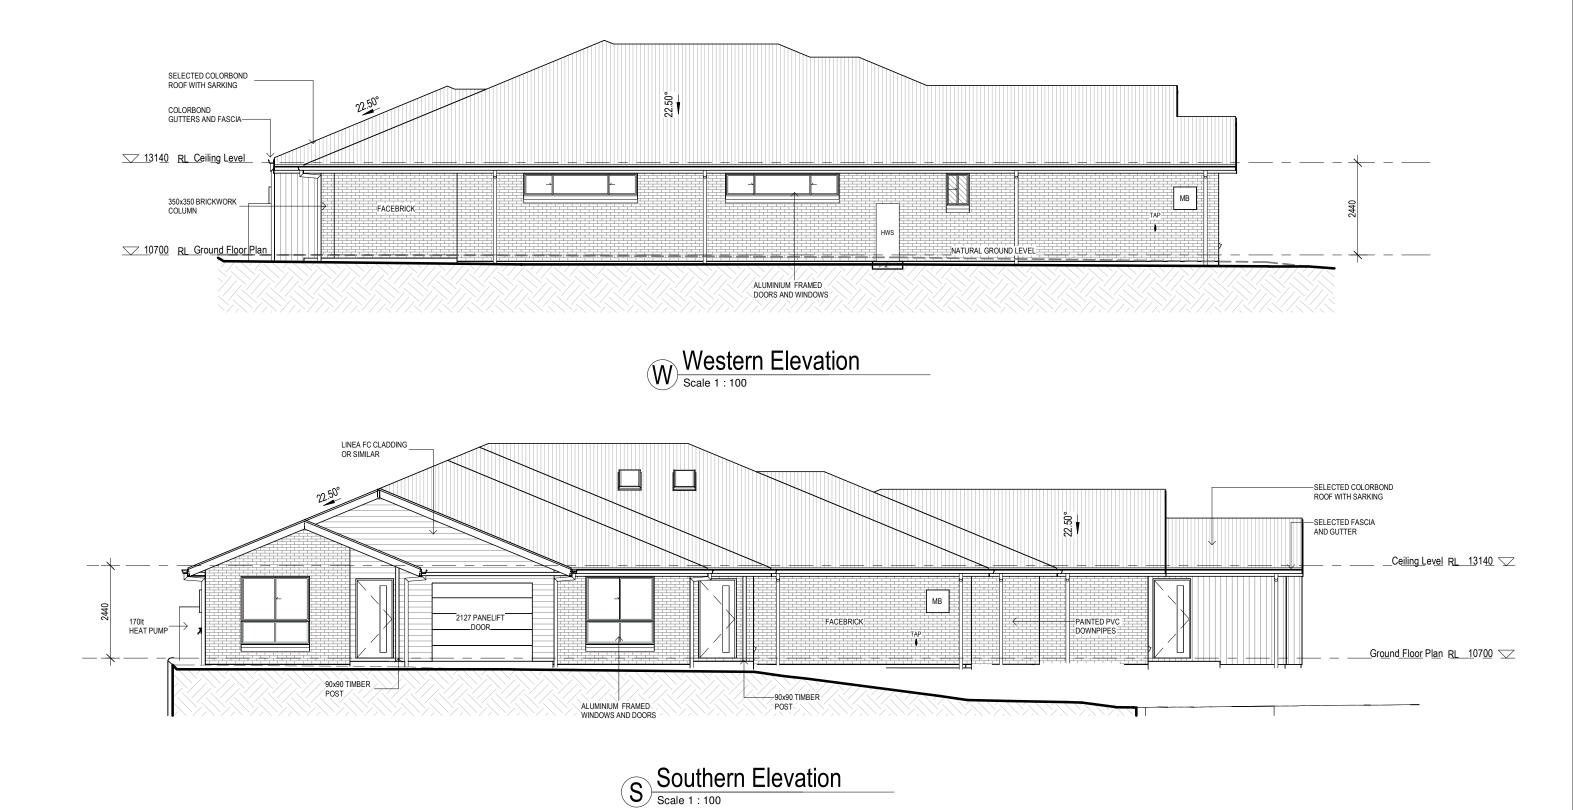




BASIX CERT. No.		SCALE	1 : 100
		DATE	01.05.2024
PLAN		DRAWN	T.J.W
	CUSTOM GABLES	DRAFT REF. No.	141-24
TITLE		JOB No.	DWG No.
	ELEVATIONS		03-2

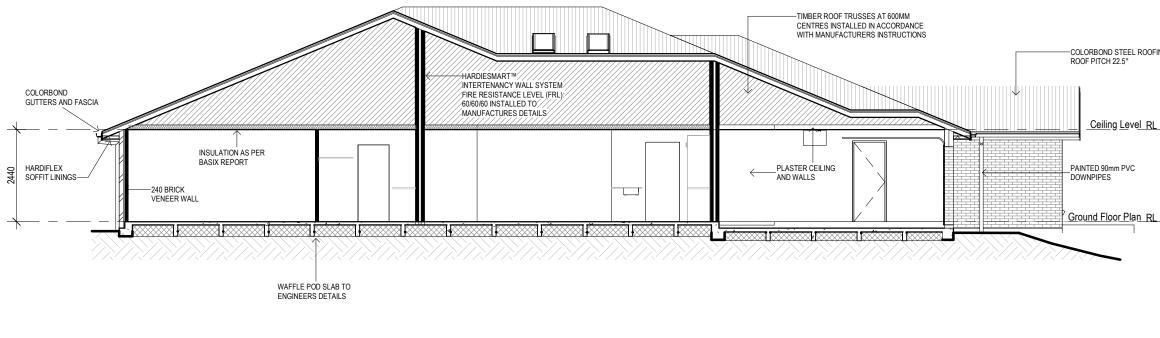



		PROPOSED NEW RESIDENCE	BASIX CERT. No.	SCALE	1 : 100
		FOR LOGAN		DATE	01.05.2024
	ZTUMGS DATE///	AT LOT 59 DP1297467	PLAN	DRAWN	T.J.W
	IG NETWORK OF PROFESSIONAL BUILDERS	No. 22 DRIFTWOOD BOULEVARD	CUSTOM GABLES	DRAFT REF. No.	141-24
PROVIDED FOR THE USE /	AS DESCRIBED AND MAY NOT BE USED OR OR IN PART WITHOUT WRITTEN CONSENT	OLD BAR 2430	TITLE	JOB No.	DWG No.
Rev Amendment Date COPYRIGH	HT HOTONDO PTY LTD DATE		SECTION		04-1

	GENERAL SPECIFICATION
ING	SPECIFICATIONS GENERAL - IT IS RESPONSIBILITY OF BUILDER TO VERIFY ALL DOCUMENTS AS TO THEIR ACCURACY AND SUITABILITY - PLANS TO BE READ IN CONJUNCTION WITH STRUCTURAL ENGINEERS DRAWINGS AND ALL OTHER RELEVANT CONSULTANTS DRAWINGS WHERE APPLICABLE. - NCC - NATIONAL CONSTRUCTION CODE - VOLUME 2 - HOUSING PROVISIONS - IF ANY DISCREPANCY, AMBIGUITY, ERROR OR INCONSISTENCY IS FOUND IN THIS SET OF DRAWINGS, REPORT TO HPC BEFORE PROCEEDING. -ALL DIMENSIONS TO BE VERIFIED BEFORE ANY WORK OR FABRICATION COMMENCES.
_ 1 <u>3140 </u>	STATUTORY REQUIREMENTS - ALL WORK TO BE CARRIED OUT IN ACCORDANCE WITH THE NCC CONDITIONS IMPOSED BY LOCAL AUTHORITY, & COMMITMENTS NOTED IN RELEVANT BASIX CERTIFICATE - THE BUILDER IS TO COMPLY WITH REQUIREMENTS OF ALL LEGALLY CONSTITUTED AUTHORITIES HAVING JURISDICTION OVER BUILDING WORKS AND PROVISIONS OF THE HOME BUILDING ACT. - BUILDER SHALL PROVIDE TEMPORARY TOILET FACILITIES FOR THE USE OF THE SUBCONTRACTORS
_ 10700	NCC REQUIREMENTS - ALL EARTHWORKS SHALL BE IN ACCORDANCE WITH ENGINEER'S DETAILS & PART 3.2 OF NCC. ALL EXCAVATIONS & UNDERFLOOR FILL SHALL BE IN ACCORDANCE WITH ENGINEER'S DETAILS & PART 3.1.1 OF NCC - PRIMARY BUILDING ELEMENTS TO BE PROTECTED FROM SUBTERRENEAN TERMITES IN ACCORDANCE WITH PART 3.4 OF NCC - PROVIDE ADEQUATE CROSS VENTILATION TO SPACE UNDER SUSPENDED GROUND FLOORS IN ACCORDANCE WITH PART 6.2.1 OF NCC - STORMWATER DRAINAGE SHALL BE CARRIED OUT IN ACCORDANCE WITH PART 3.3 OF NCC ALL TIMEER ERAMEWORK SHALL CONDLY WITH NCC OR AS1684
	 ALL TIMBER FRAMEWORK SHALL COMPLY WITH NCC OR AS1684 ROOF TRUSSES SHALL BE DESIGNED IN ACCORDANCE WITH AS1720 & INSTALLED IN ACCORDANCE TO MANUFACTURER'S SPECIFICATIONS STRIP & SHEET FLOORING SHALL BE IN ACCORDANCE WITH MANUFACTURER'S SPECIFICATIONS ALL ROOF CLADDING SHALL DE IN ACCORDANCE WITH MANUFACTURER'S SPECIFICATIONS ALL ROOF CLADDING SHALL DE IN ACCORDANCE WITH PART 7.4 OF NCC SARKING SHALL COMPLY WITH AS/NZ54200.1 & 2 FLASHING SHALL COMPLY WITH AS/NZ54200.1 & 2 FLASHING SHALL COMPLY WITH AS/NZ54200.1 & 2 FLASHING SHALL COMPLY WITH EITHER AS4773 OR AS3700 CUAY BRICK WORK SHALL COMPLY WITH EITHER AS4773 OR AS3700 CONCRETE BLOCK WORK SHALL DE CONSTRUCTED IN ACCORDANCE WITH EITHER AS4773 OR AS3700 AUTOCLAVED AERATED CONCRETE PRODUCTS SHALL E INSTALLED IN ACCORDANCE WITH MANUFACTURER'S SPECIFICATIONS AS 5416.1 DAMP PROOF COURSES & CAVITY VENTILATION SHALL COMPLY WITH EITHER AS4773 OR AS3700 MORTAR & JOINT TOLERANCES SHALL DE IN ACCORDANCE WITH EITHER AS4773 OR AS3700 MORTAR & JOINT TOLERANCES SHALL COMPLY WITH EITHER AS4773 OR AS3700 MORTAR & JOINT TOLERANCES SHALL COMPLY WITH EITHER AS4773 OR AS3700 MASONRY VENEER SHALL COMPLY WITH PART 5.2 OF NCC ENGAGED PIERS IN SINGLE LEAF MASONRY WALLS SHALL BE CONSTRUCTED FROM CORROSION SHALL COMPLY WITH PART 5.2 OF NCC ENGAGED PIERS IN SINGLE LEAF MASONRY WALLS SHALL BE CONSTRUCTED IN ACCORDANCE WITH EITHER AS4773 OR AS3700 MNEONAL WET AREAS TO BE WATERPROOFED IN ACCORDANCE WITH PART H2DB OF NCC. ENGAGED PIERS IN SINGLE LEAF MASONRY WALLS SHALL BE CONSTRUCTED FROM CORROSION SHALL COMPLY WITH PART 5.2 OF NCC ENGAGED PIERS IN SINGLE LEAF MASONRY WALLS SHALL BE ONSTRUCTED IN ACCORDANCE WITH PART 5.0 OF NCC MNEONAL WET AREAS TO BE WATERPROOFED IN ACCORDANCE WITH PART H2DB OF NC
	PLEASE NOTE: THE STANDARDS REFERENCED IN THE TABLE ARE THE RELEVANT VERSION ADOPTED BY THE NCC AT THE TIME THE CONSTRUCTION CERTIFICATE OR COMPLYING DEVELOPEMNT CERTIFICATE APPLICATION WAS LODGED.

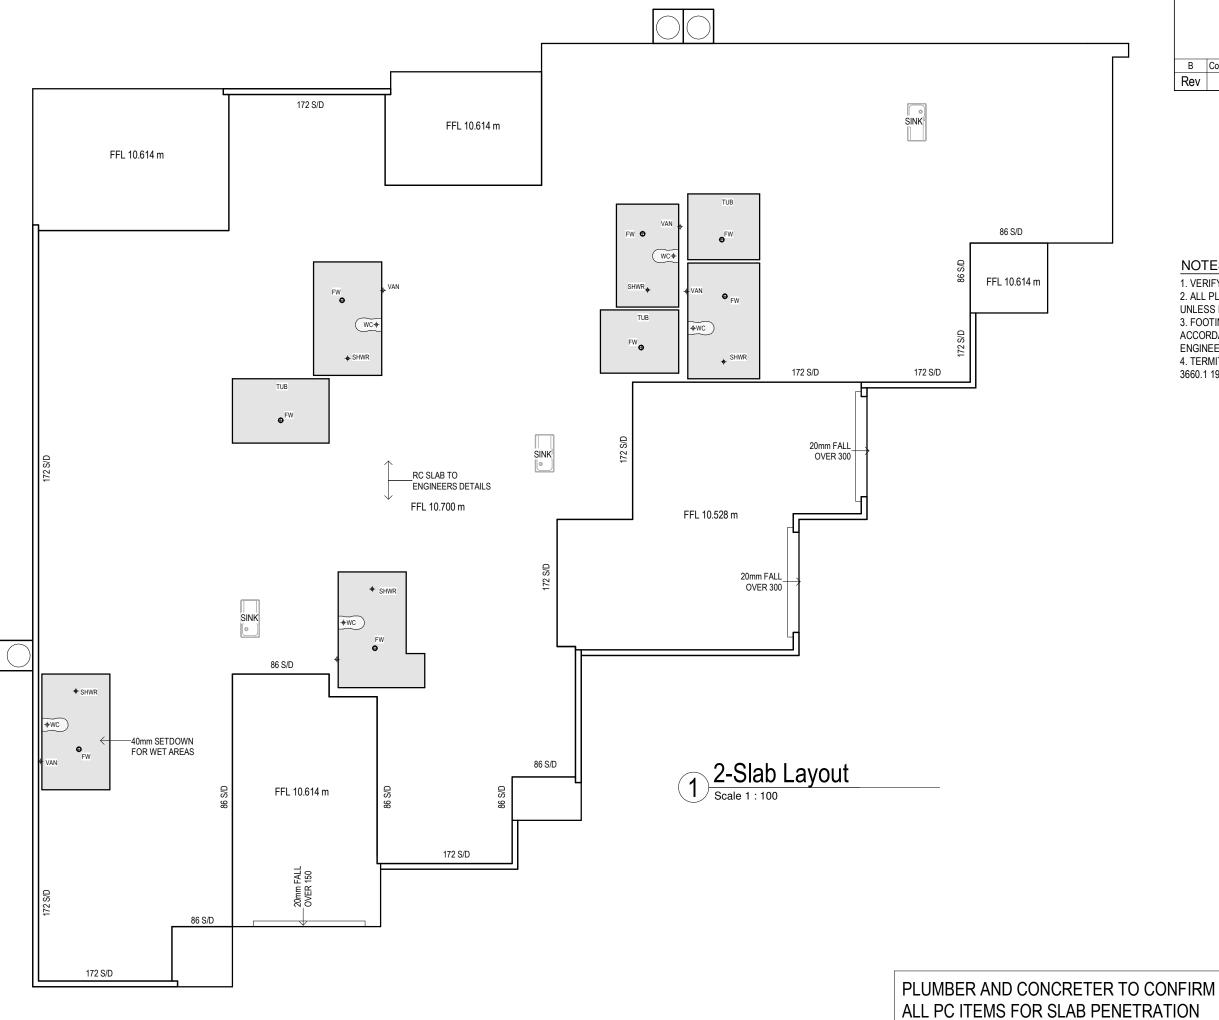


В	Council Issue	01.05.24
Rev	Amendment	Date

NOTES

1. VERIFY ALL DIMENSIONS PRIOR TO COMMENCEMENT. 2. ALL PLAN DIMENSIONS ARE TO OUTSIDE OF BRICK WORK UNLESS NOTED OTHERWISE. 3. FOOTINGS AND SLAB CONSTRUCTION TO BE IN ACCORDANCE WITH ANY GEOTECHNICAL REPORT & ENGINEER'S DETAIL FOR THIS ALLOTMENT. 4. TERMITE PROTECTION TO BE IN ACCORDANCE WITH AS 3660.1 1995 AND B.C.A. 3.1.3.

CLIENT DATE///				
BUILDER DATE/	/			
AUSTRALIA'S LEADING NETWORK THIS DRAWING REMAINS THE PROPERT PRODUCED IN WHOLE OR IN PART WIT COPYRIGHT HOT	Y OF HOTONDO PTY LTD AND IS D AND MAY NOT BE USED OR THOUT WRITTEN CONSENT			
141-24				
for LOGAN				
AT LOT 59 DP1297467 No. 22 DRIFTWOOD BOULEVARD OLD BAR 2430				
TITLE				
SLAB LAYOUT				
SCALE	1 : 100			
DATE	01.05.2024			
DRAWN	T.J.W			
SHEET SIZE:	A3			
JOB No.	DWG No. 05-1			

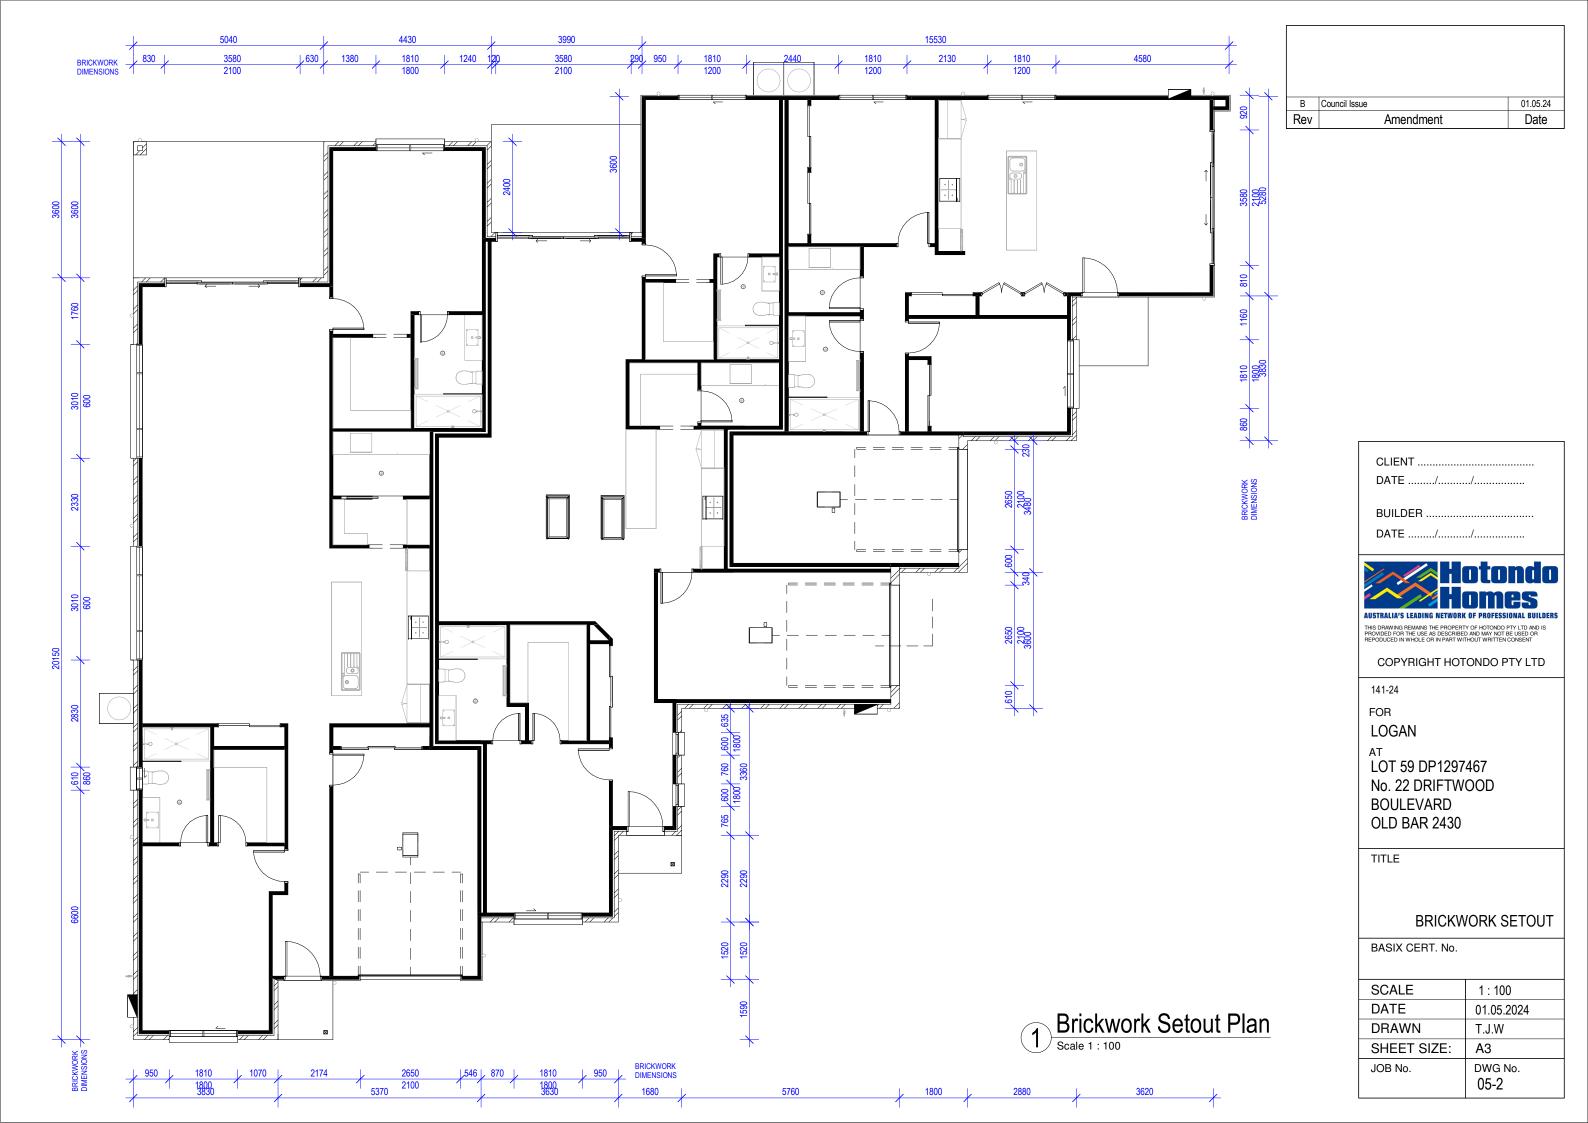



В	Council Issue	01.05.24
Rev	Amendment	Date
-		

LEC	TRICAL LEGEND	
BOL	ITEM	QTY
	LED DOWNLIGHT	
	EXTERNAL LIGHT POINT CEILING	
	DOWNLIGHT	
Р	PENDANT LIGHT	
)	INTERNAL LIGHT POINT	
)	CIRCULAR FLURO	
,	OUTDOOR WALL SCONCE	
フ	LIGHT POINT WALL	
	CEILING MOUNTED FLUORESCENT	
Б	TWIN SPOT SENSOR LIGHT	
,	SINGLE POWERPOINT	
~	DOUBLE POWERPOINT	
wp ▼	WEATHERPROOF POWERPOINT (DOUBLE / SINGLE)	
USB V	POWER POINT WITH USB OUTLETS	
\rightarrow	EXHAUST FAN CEILING	
8	TASTIC 2 HEATER/ LIGHT/FAN	
X	TASTIC 4 HEATER/ LIGHT/FAN	
V	TV POINT	
NBN	PHONE POINT / NBN POINT	
AS	GAS POINT	
K	CEILING FAN	
K	CEILING FAN LIGHT COMBO	
ACCO COMF SMOK CONS MAINS APPR COVE	E ALARMS MUST BE INSTALLED IN RDANCE WITH PART 9.5 OF NCC; AN PLY WITH AS 3786. E ALARMS MUST BE CONNECTED T UMER MAINS POWER WHERE CONS S POWER IS SUPPLIED TO THE BUILT OVED DOWNLIGHT NON-VENTILATE R OR SHIELD TO ALL CEILING TRATIONS FOR LIGHTING	o the Sumer Ding

CLIENT DATE/				
BUILDER DATE/				
AUSTRALIA'S LEADING NETWORK THIS DRAWING REMAINS THE PROPERT PROVIDED FOR THE USE AS DESCRIBE REPODUCED IN WHOLE OR IN PART WIT COPYRIGHT HOT	D AND MAY NOT BE USED OR THOUT WRITTEN CONSENT			
141-24				
for LOGAN	FOR			
AT LOT 59 DP1297467 No. 22 DRIFTWOOD BOULEVARD OLD BAR 2430				
TITLE				
	ELECTRICAL			
BASIX CERT. No.				
SCALE	1 : 100			
DATE	01.05.2024			
DRAWN	T.J.W			
SHEET SIZE:	A3			
JOB No.	DWG No. 06			



Attachment 2 – Compliance with Development Standards

Development Standards	Proposal	Compliance
 The development conforms to the specifications and requirements of the following that are relevant to the development: 1. PBP 2019; and 2. If another document is prescribed by the regulations for the purposes of Section 4.14 of the EP&A Act – that document. 	The proposal complies with the relevant Bush Fire Protection Measures as outlined in PBP and the proposed development has been assessed as BAL-12.5	The proposed development has been assessed as BAL-12.5.
The part of the lot on which the development is to be carried out is not in bushfire attack level-40 (BAL-40) or the flame zone (BAL-FZ); and	The proposal does not occur on land that has been assessed as BAL-40 and BAL-FZ.	Complies
The lot has direct access to a public road or a road vested in or maintained by the council; and	The lot has direct access to the Public Road	Complies
A reticulated water supply is connected to the lot; and	The site is connected to reticulated water.	Complies
A fire hydrant is located less than 70m from the location of the lot of the proposed development; and	A fire hydrant occurs within 70m of the lot	Complies – refer to Attachment 3 for hydrant placement.
A 10,000L water supply with 65mm metal Storz outlet with a gate or ball valve is provided for firefighting purposes on the lot (the gate or ball valve, pipes and tank penetrations are to be designed to allow for a full 50mm inner diameter water flow through the Storz fitting and must be of a metal construction). All above-ground water storage tanks shall be of concrete or metal.	N/A	N/A
Mains electricity is connected to the lot; and	The site is connected to electricity	Complies
Reticulated or bottled gas on the lot is installed and maintained in accordance with AS/NZS 1596:2008 The storage	Can Comply	Can comply

Firebird ecoSultants Pty Ltd

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	Development Standards	Proposal	Compliance
and handling of LP Gas and the requirements of relevant authorities (metal piping must be used); and			
	as cylinders on the lot that are 10m of the dwelling house;	Can comply	Can comply
i.	Have the release valves directed away from the dwelling house; and		
ii.	Are enclosed on the hazard side of the installation; and		
iii.	Have metal connections to and from the cylinders; and		
iv.	There are no polymer sheathed flexible gas supply lines to gas metres adjacent to the dwelling		
The requirements of AS3959-2018 set out in the BCA also apply		Assessment in accordance with AS3959-2018 and PBP 2019 has concluded that the proposed development has been assessed as BAL-12.5	The proposed development has been assessed as BAL-12.5.



Firebird ecoSultants Pty Ltd ABN-16 105 985 993

Attachment 3 – Hydrant and Water Compliance

 Firebird ecoSultants Pty Ltd


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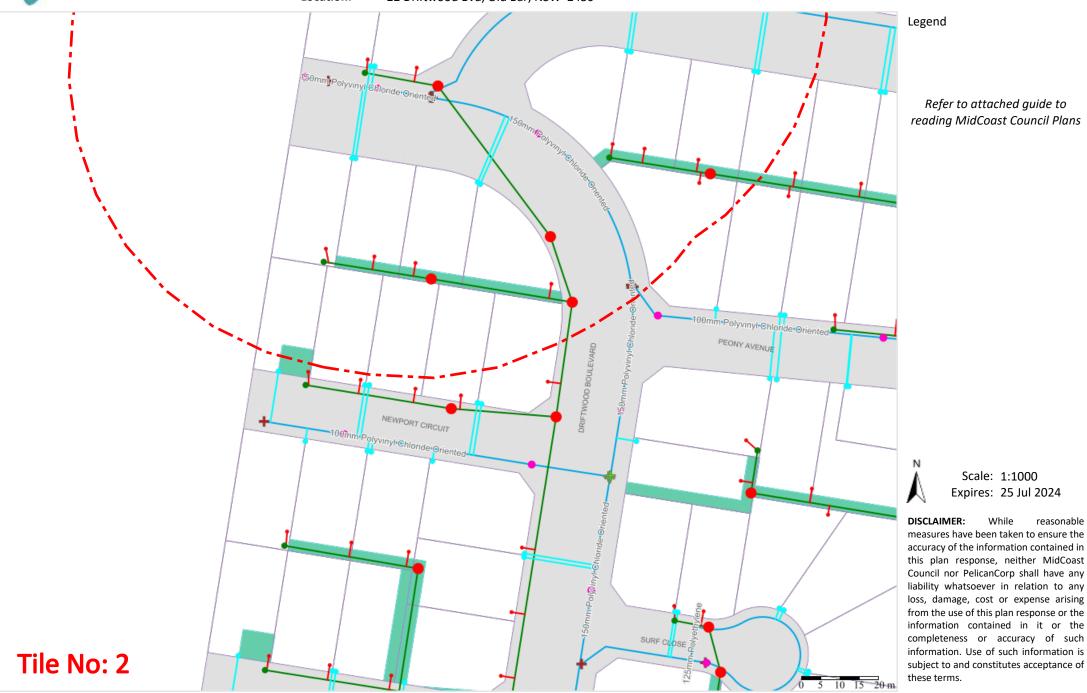
 E: sarah@firebirdeco.com.au





Sequence No: 241125546 Job No: 36999642 Location: 22 Driftwood Bvd, Old Bar, NSW 2430



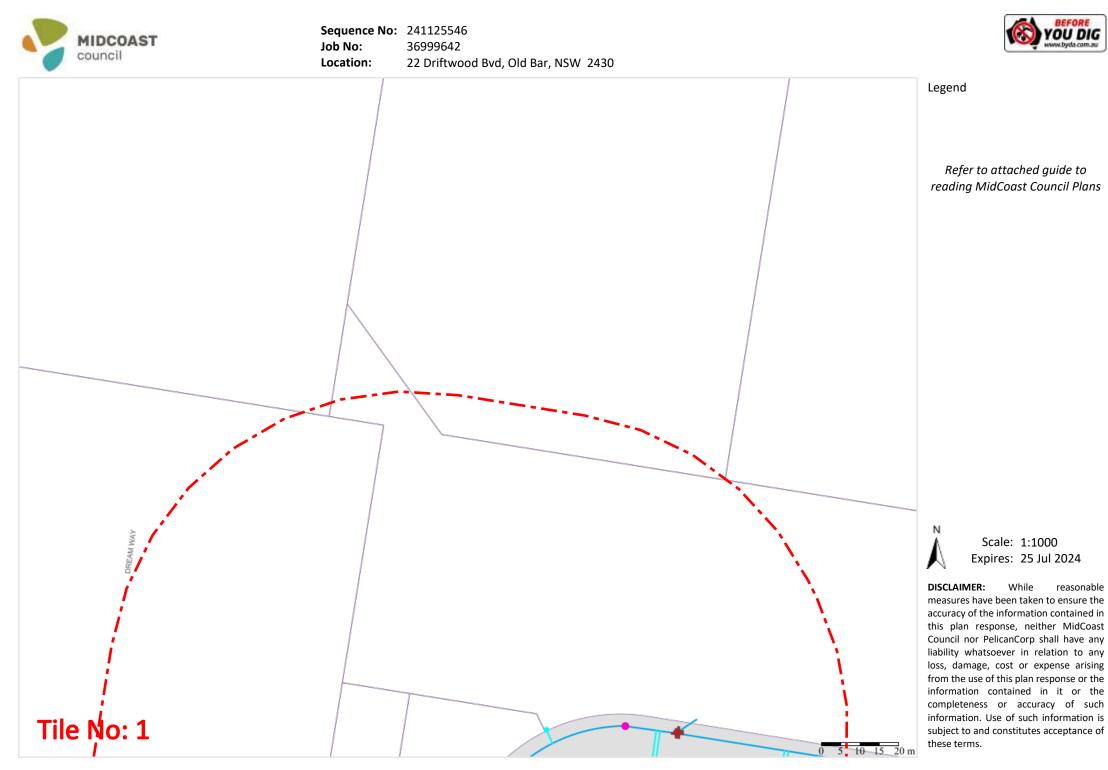

MIDCOAST

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reasonable

Guide to reading MidCoast Council

Before You Dig Australia Plans

This guide will help you understand our plans and what our services are.

Sewer		<u>w</u>	<u>/ater</u>
Manhole	•	Service Connection	lacksquare
Service Connection	•	Scour Valve	
Air Valve	$\boldsymbol{\wedge}$	Air Release Valve	
Check Valve		Pressure Reducing Valve	0
Pressure Reducing Valve		Check Valve	0
Reflux Valve	\land	Backflow Preventer	0
Regulating Valve		Penstock Valve	0
Scour Valve		Filling Station	
Vacuum Interface Valve	•	Gate Valve - Open	÷
Gate Valve - Open	•	Gate Valve - Closed	+
Gate Valve - Closed	+	Butterfly Valve	÷
MidCoast Council Pump		Knife Gate Valve	•
Private Pump	\odot	Hydrant	•
Ventstack		Pump	
Flow Meter	•	End Cap	•
Treatment Plant		Taper	
Lateral Lines		Flow Meter	ightarrow
Relined Mains	—	Fitting	0
Gravity Main	_	Reservoir	
Overflow	_	Tank	•
Vent Shaft	—	Source	•
Vacuum Main	—	MCC Lateral Lines	_
Rising Main	_	Private Lines	
Pressure Retic Main		Distributor	_
Asbestos Cement Pipes		Reticulation	_
Boundary Kit		High Pressure	_
End Cap	•	Internal	_
Fitting	•	Link	—
		Asbestos Cement	-

If you have any questions regarding this Legend and its use, contact MidCoast Council Customer Service on (02) 7955 7777.

Disclaimer: This map is a schematic representation of data produced by a Geographical Information System (GIS) exclusively for employees of MidCoast Council, but may also be used by clients/customers to assist with the identification and provision of services subject to terms and conditions. No responsibility is accepted for the accuracy of the map or the data that it contains.

